

ELEVATIONS NORTH WEST ELEVATION

ELEVATIONS

FRONT ELEVATION

SCALE 1:100

SCALE 1:100



EXTERNAL FINISHES

AFG- ALUMINUM FRAME GLAZING

ATP- ALUMINUM TIMBER LOOK PERGOLA

TEXTURE RENDERED WALL

CUTOMIZED ALUMINUM FRAME

METAL BATTEN SCREEN

RENDERED AWNING

ROLLER SHUTTER SANDSTONE CLADDING ST-

CUTOMIZED TIMBER DOOR

ALL LEVELS ARE INDICATIVE AND TO BE COORDINATED WITH CIVIL ENGINEER'S FUTURE DETAILS AND EARTHWORKS. ALL LEVEL ARE TO BE +/- 500 mm.

FOR DA SUBMISSION

PROJECT ADDRESS 17 ANEMBO AVE, GEORGES HALL, NSW 2198


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- . DISABILITY ACCESS AND FACILITIES TO BE IN ACCORDANCE WITH AS 1428.1 AND AS 1428.4
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CLIENT CHERYL NGUYEN

BUILDING DESIGNER

OIC

OIC DESIGN PTY LTD. (ABN 89 645 958 247) A1/ 35-39 BURKE ROAD ALEXANDRIA NSW 2015 Ph. 04 5066 1226


PROJECT

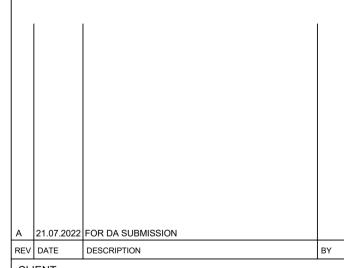
17 ANEMBO AVE, GEORGES HALL, NSW 2198

ELEVATIONS

DRAWING NO. REVISION SCALE 1:100 @ A1 DA- 500

JOB NUMBER DRAWN BY 2101 JUL 22 CC

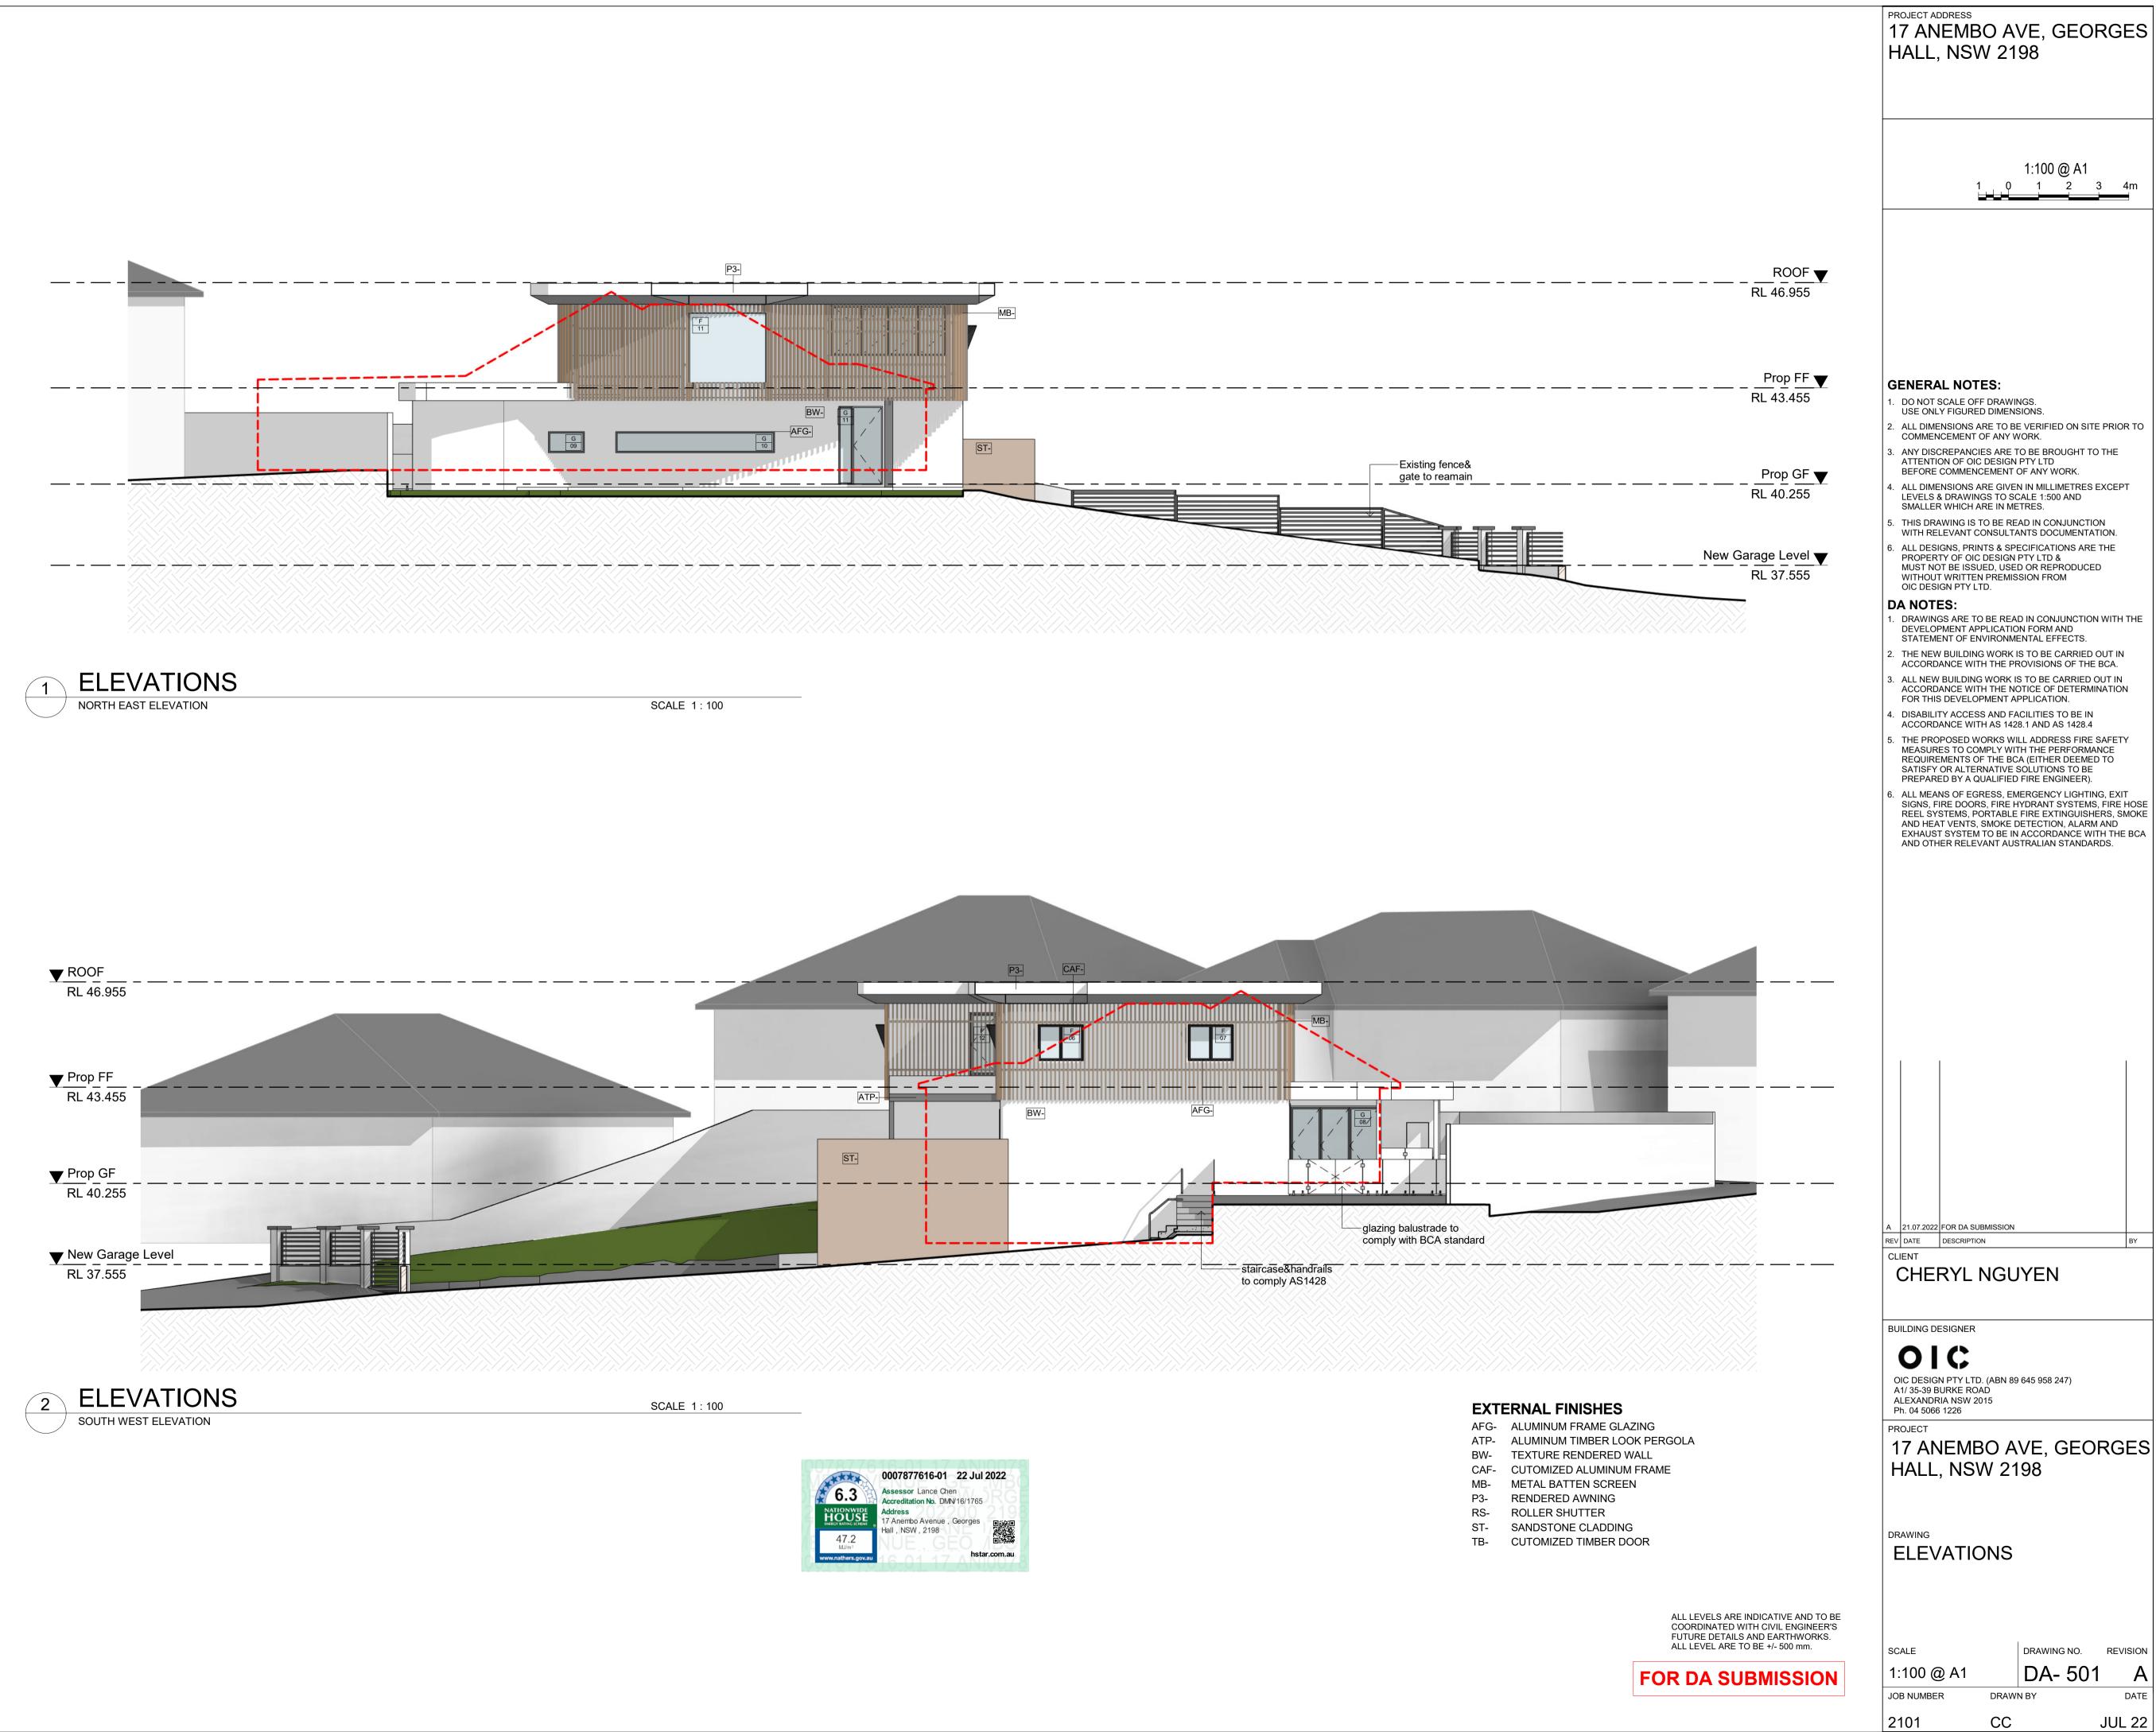

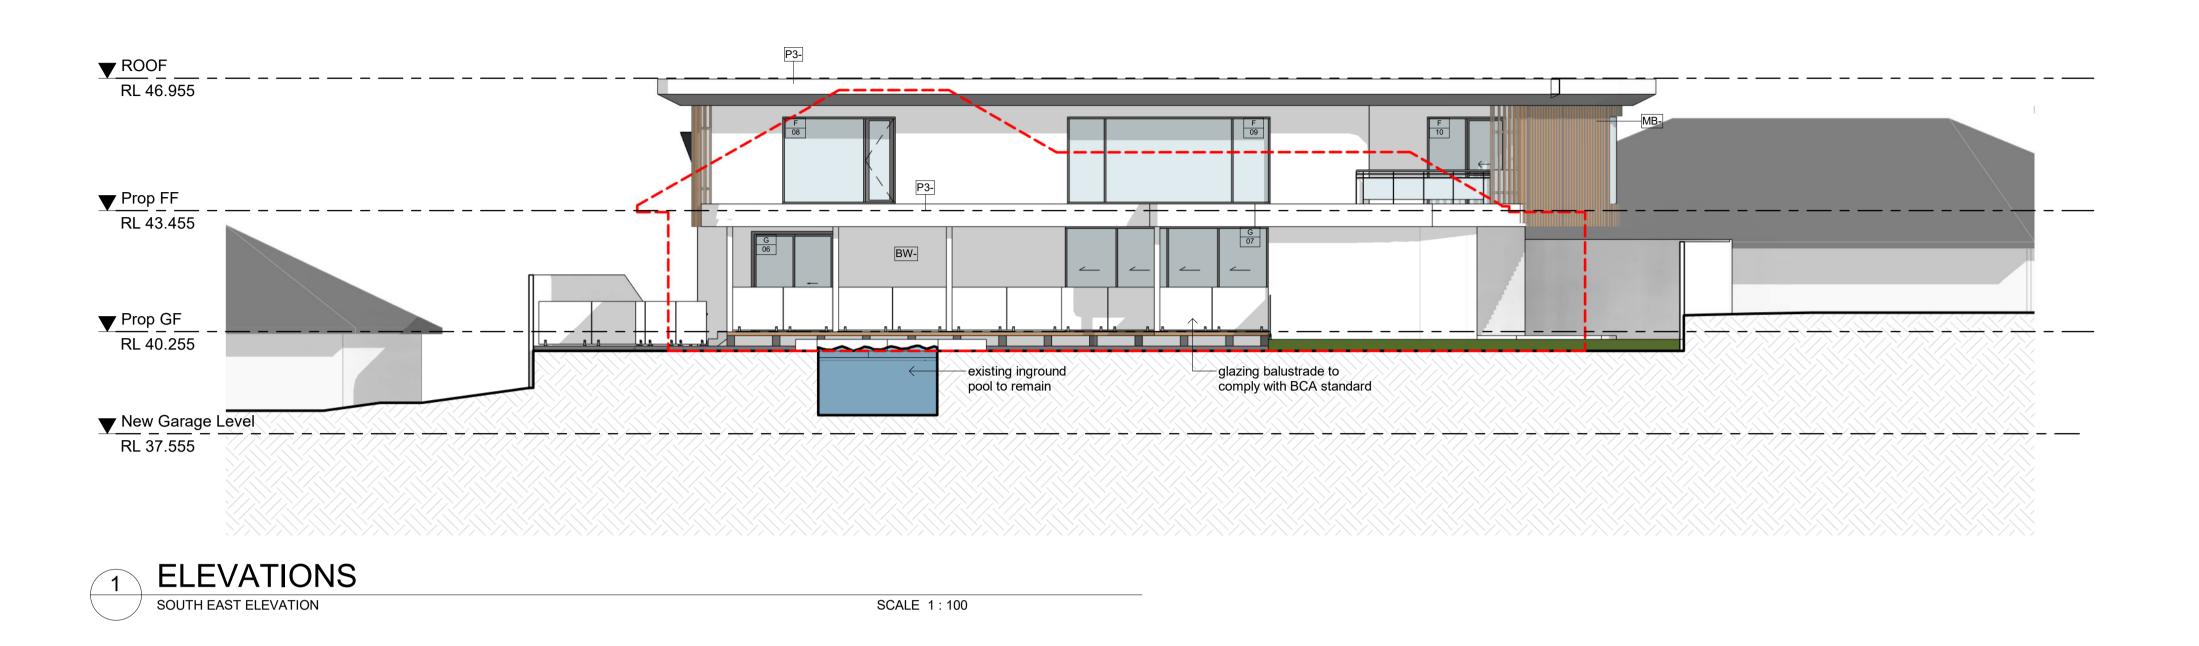

BASIX Thermal Specification – 17 Anemo Ave, Georges Hall NSW

Element	Construction	Details
Roof / Ceiling		Medium colour (0.475≤Solar Absorptance≤0.7)
	Concrete flat roof + Plasterboard (PB) ceiling without insulation	Applicable to the exposed roof over the basement floor
	Concrete flat roof + R3.5 bulk insulation + PB	Applicable to the exposed roof over the ground floor and roof over the first floor
Internal ceiling	Concrete slab + PB ceiling without insulation	Applicable to all the internal ceilings
External walls	Concrete walls without insulation	Applicable to the retaining walls on the basement floo
	Double Brick walls without insulation	Light colour (Solar Absorptance<0.475) Applicable to the other external walls on the basement floor except for the above and the external walls forming the staircase on the ground floor
	Double Brick + R1.0 bulk insulation + PB	Applicable to all other external walls except those for the above
Internal walls	Concrete walls without insulation	Applicable to the internal walls at the basement
	Concrete block walls without insulation	Applicable to the internal walls forming staircase at the ground floor
	Single brick walls without insulation	Applicable to the other internal walls except those for the above
Windows	Aluminium frame, weather stripping fitted, single low-e glazed, high solar gain	Applicable to all the windows and glazed doors NFRC glazing system (Glass+Frame) values – Group A (hinged door type): U = 5.4 and SHGC = 0.49; Group B (fixed, sliding and double hung types): U = 5.4 and SHGC = 0.58;
	Note that all glazing installed shall have the U values values within +/- 10% of those specified above.	not more than those specified above and the SHGC
Skylights (rooflights)	Standard aluminium frame, weather stripping fitted, double glazed, clear	As per plans
Floors	Concrete slab on ground without insulation	Applicable to the basement floor and part of the ground floor
	Suspended concrete floor without insulation	Applicable to the first floor and part of the ground floo (where above the basement)
	Floor coverings	Living areas: timber; Kitchen and all wet areas: tile; Bedrooms: carpet; Basement: bare concrete
Downlights	If to be planned, IC rated LED downlights recommended to be used throughout	Rating without downlights due to lighting layout plans / RCPs not available at the current stage. Rating with downlights (if planned) shall be required when lighting layout design is completed
		prior to application of construction certificate.



EXTERNAL FINISHES

AFG- ALUMINUM FRAME GLAZING ATP- ALUMINUM TIMBER LOOK PERGOLA BW- TEXTURE RENDERED WALL CAF- CUTOMIZED ALUMINUM FRAME METAL BATTEN SCREEN

RENDERED AWNING **ROLLER SHUTTER**

SANDSTONE CLADDING ST-CUTOMIZED TIMBER DOOR

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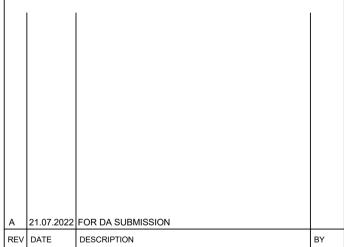
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CHERYL NGUYEN

BUILDING DESIGNER

OIC DESIGN PTY LTD. (ABN 89 645 958 247) A1/ 35-39 BURKE ROAD

ALEXANDRIA NSW 2015 Ph. 04 5066 1226

PROJECT

17 ANEMBO AVE, GEORGES HALL, NSW 2198

2101


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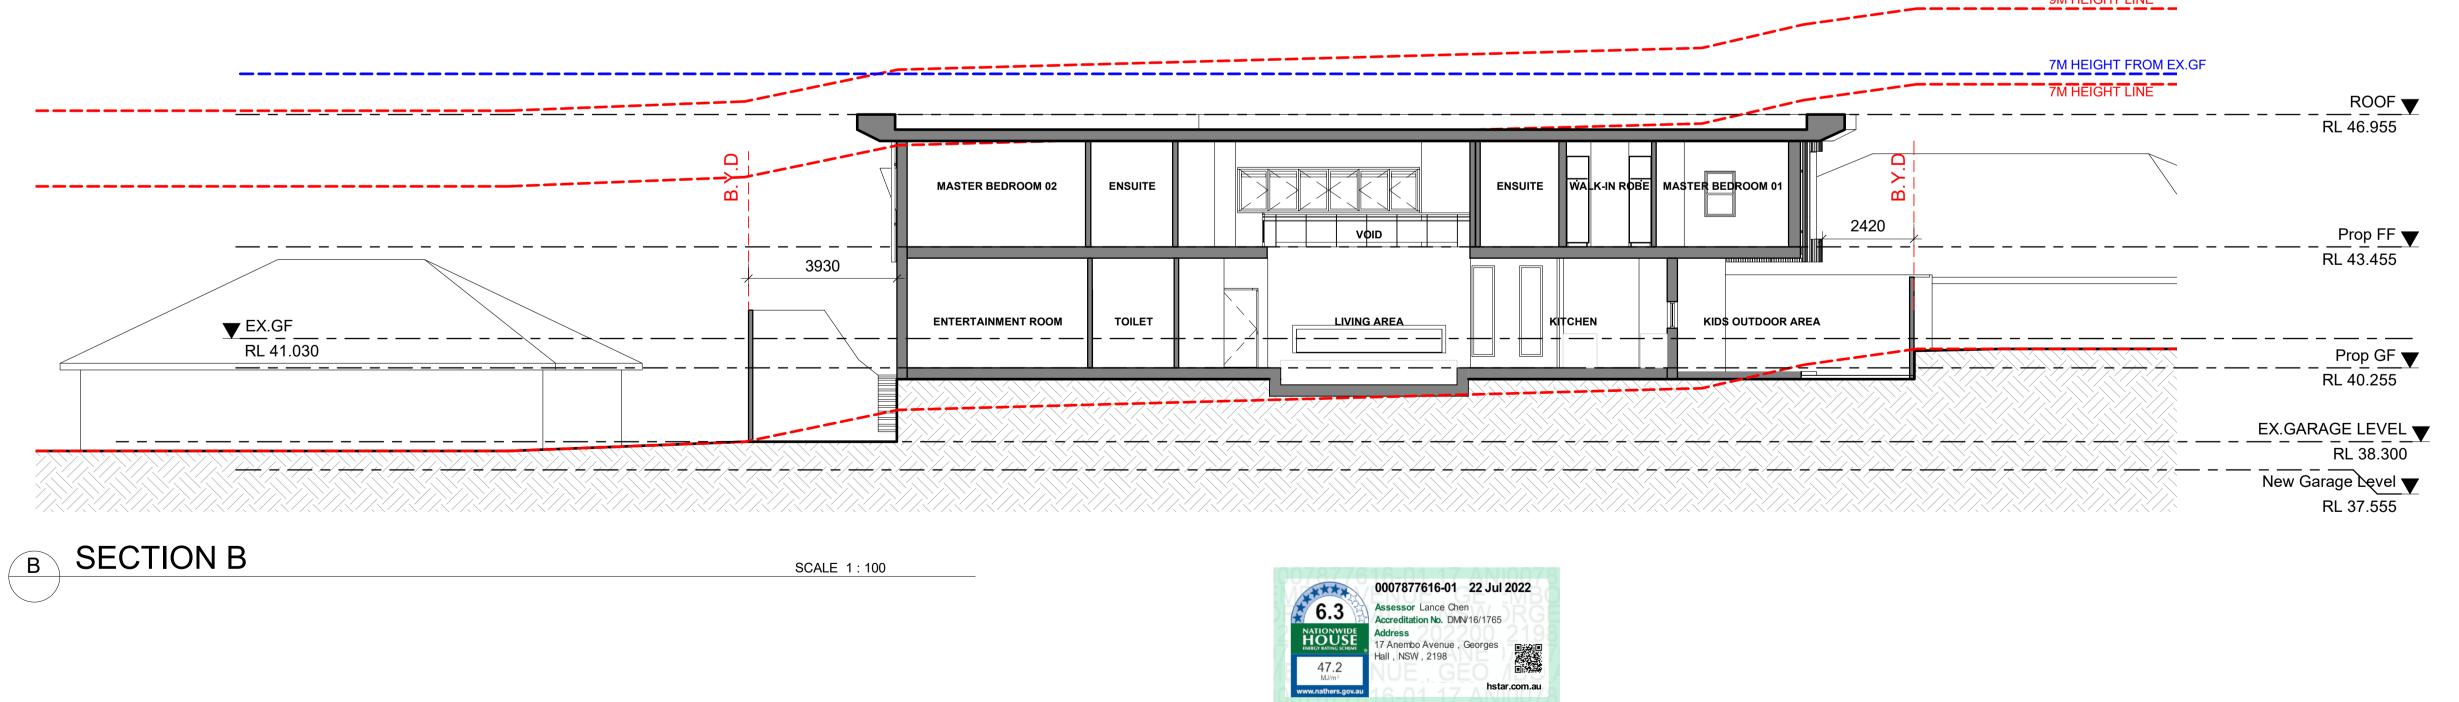
1:100 @ A1 DA- 502 JOB NUMBER DRAWN BY

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JUL 22



SCALE 1:100

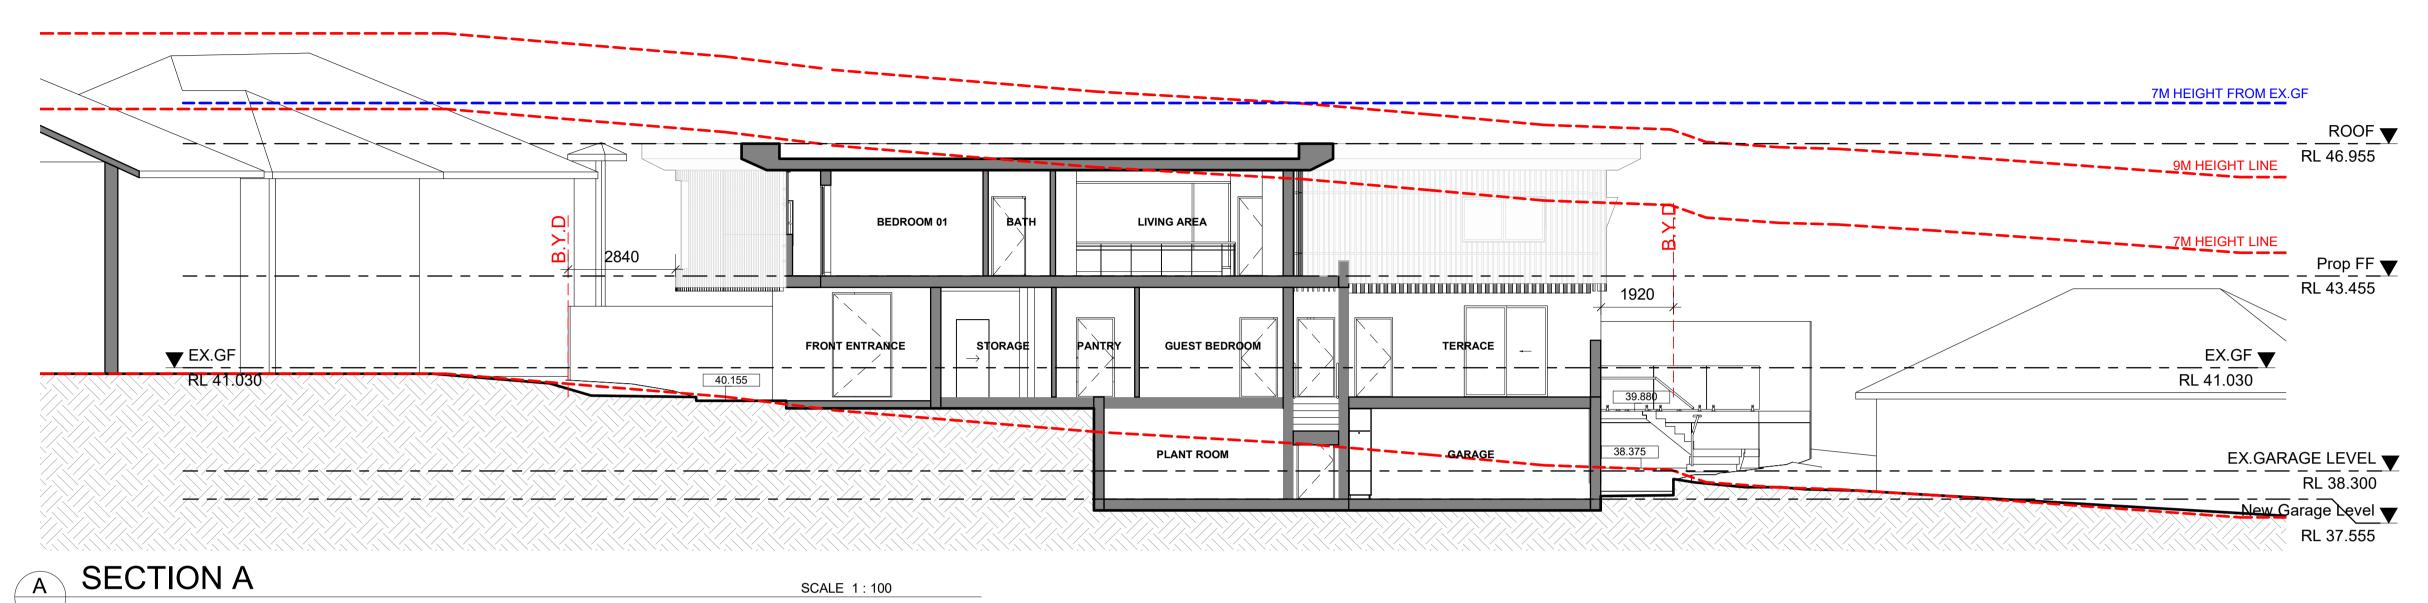

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